FUTURE STAGE STAGE 2 SHORTLAND WATERS GOLF CLUB STAGE 1 UNIVERSITY OF NEWCASTLE CALVERY MATER HOSPITAL

LOCATION PLAN 1:8000 at A1

STAGE 2: SHORTLAND WATERS RETIREMENT VILLAGE - LANDSCAPE DA DOCUMENTATION

Sheet No.	Sheet Name	Revision	Date
LP-001	COVER SHEET	В	16/2/17
LP-002	ANALYSIS PLAN	В	16/2/17
LP-003	MASTER PLAN	В	16/2/17
LP-004	DETAIL PLAN - A	В	16/2/17
LP-005	DETAIL PLAN - B	В	16/2/17
LP-006	DETAIL PLAN - C	В	16/2/17
LP-007	SECTIONS	В	16/2/17
LP-008	PLANTING & THEMING	В	16/2/17



SITE PLAN 1:800 at A1



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5. CONFIRM LOCATION OF ALL SERVICES ON SITE PRIOR TO EXCAVATION .

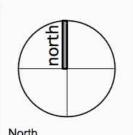
Architect:

PALADIN PROJECTS

FAITHER STRUCTURAL SITE OF THE PRIOR TO ENGINEER'S DRAWINGS AND SPECIFICATIONS .

NORTHROP

REVISION DRAFT 24/1/17 LANDSCAPE DA FOR REVIEW A 9/2/17 LANDSCAPE DA FOR SUBMISSION 16/2/17 LANDSCAPE DA FOR RESUBMISSION




DRAFT STAGE 2: SHORTLAND WATERS RETIREMENT VILLAGE 90 VALE STREET SHORTLAND, NSW 2307, LOT 1 DP1215916 AVEO GROUP

COVER SHEET Project No. SCALE: 1:8000 ORIGINAL DRAWING AT A1. Drawing No. Rev

LP-001 B

Drawn By: BN

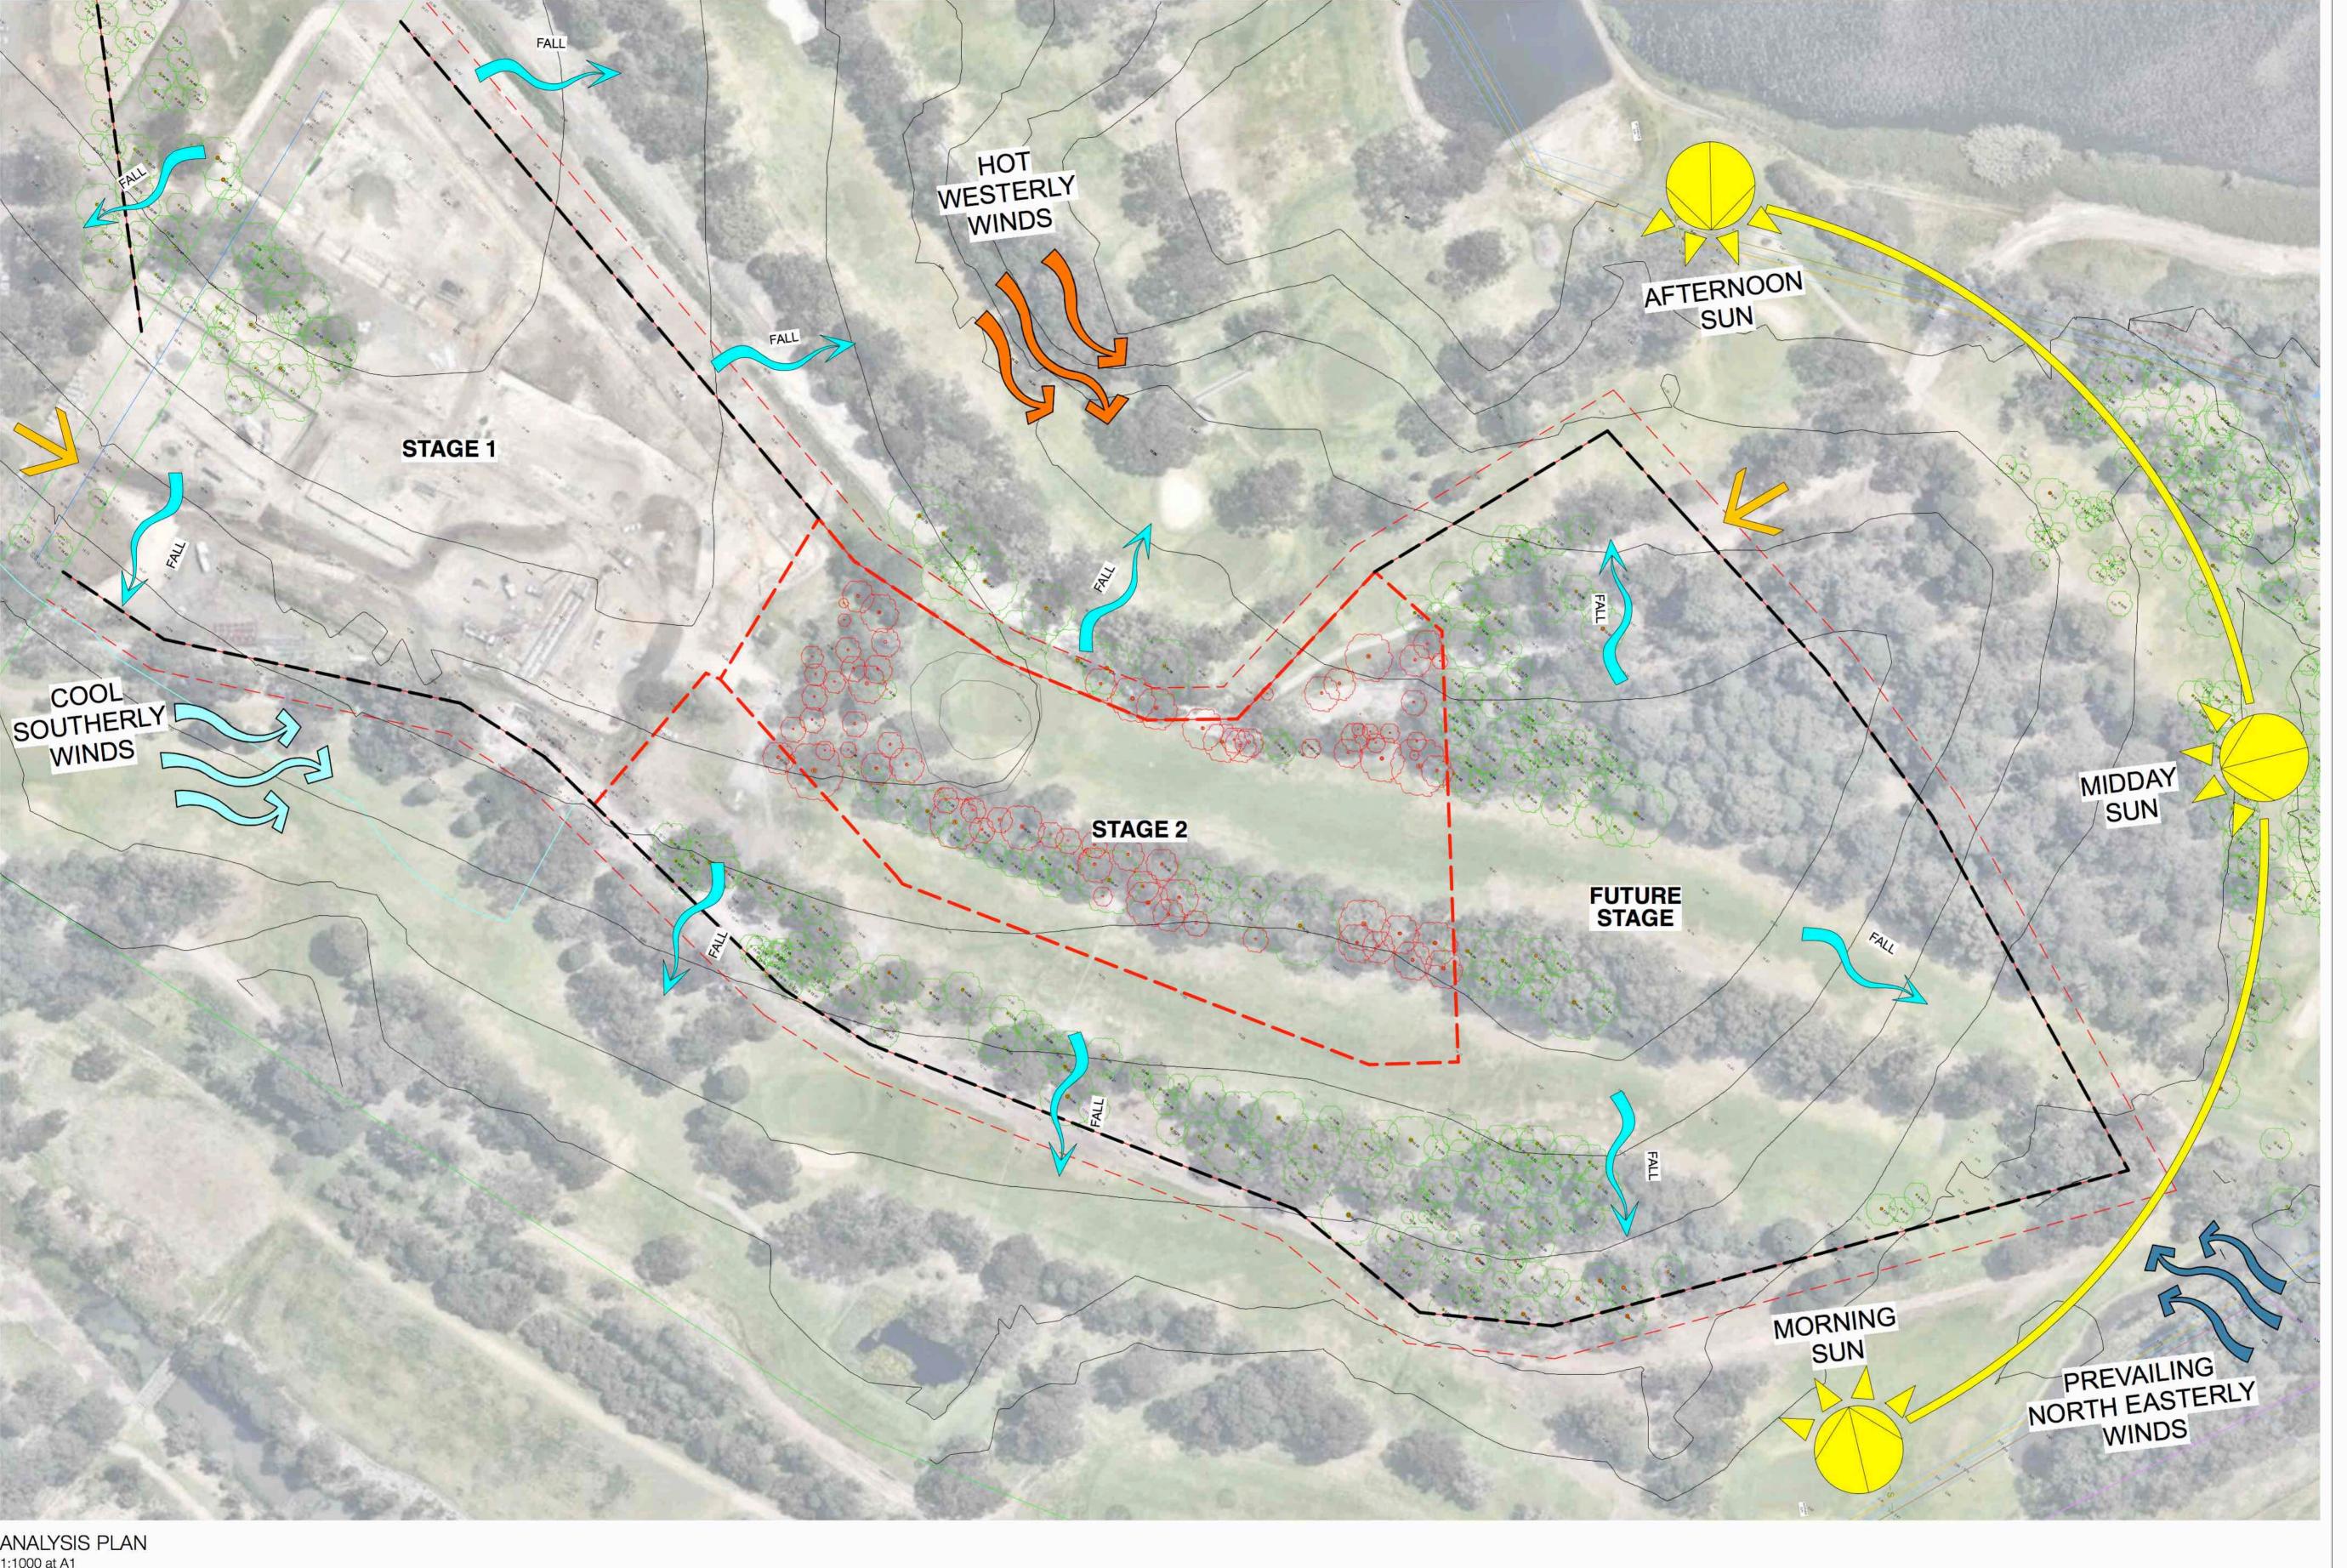Checked By: DM



LEGEND

- - EXTENT OF WORK

---- BOUNDARY LINE

----- Ex. CONTOUR

-23.50 - SPOT LEVEL

---- STORMWATER WIND DIRECTION

PROPOSED CONTOUR

EXISTING VEHICLE ACCESS

SITE WATER FALL

ANALYSIS PLAN 1:1000 at A1





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Architect:


PALADIN PROJECTS

FIGURE 1:

PALADIN PROJECTS

NORTHROP

No.	Date	REVISION	By
DRAFT	24/1/17	LANDSCAPE DA FOR REVIEW	BN
A	9/2/17	LANDSCAPE DA FOR SUBMISSION	HF
В	16/2/17	LANDSCAPE DA FOR RESUBMISSION	BN

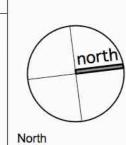

DRAFT STAGE 2: SHORTLAND WATERS RETIREMENT VILLAGE 90 VALE STREET SHORTLAND, NSW 2307, LOT 1 DP1215916 AVEO GROUP

ANALYSIS PLAN

Checked By: DM

SCALE: 1:1000 ORIGINAL DRAWING AT A1. Drawing No. Rev Drawn By: BN LP-002 B

Project No.

1380



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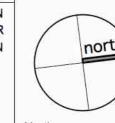
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NORTHROP

9/2/17 LANDSCAPE DA FOR SUBMISSION 16/2/17 LANDSCAPE DA FOR RESUBMISSION



STAGE 2: SHORTLAND WATERS RETIREMENT VILLAGE 90 VALE STREET SHORTLAND, NSW 2307, LOT 1 DP1215916 **AVEO GROUP**

SCALE: 1:400 ORIGINAL DRAWING AT A1. Checked By: DM

1380 Drawing No. Rev LP-003 B



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Architect:

PALADIN PROJECTS

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Drawing No. Rev LP-004 B


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Checked By: DM

LEGEND

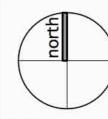Drawing No. Rev LP-005 B





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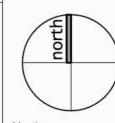
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A 9/2/17 LANDSCAPE DA FOR SUBMISSION 16/2/17 LANDSCAPE DA FOR RESUBMISSION



DRAFT STAGE 2: SHORTLAND WATERS RETIREMENT VILLAGE 90 VALE STREET SHORTLAND, NSW 2307, LOT 1 DP1215916 AVEO GROUP

DETAIL PLAN - C

EXTENT OF WORKS

BUGGY PARKING

CONCRETE DRIVEWAY

BUILDING FOOTPRINT

WAYFINDING/SIGNAGE

RETAINING WALL

LIGHT BOLLARD

Species include:

Frangipani)

Waterhousia floribunda Hymenosporum flavum (Native

MASS PLANTING

Pyrus calleryana 'chanticleer'

SHELTER (Skillion/Open Style)

Trees have been selected to define space and function, to provide privacy, seaonal variation and habitat. Planting of the streetscape varies from the species selection in the open space areas, and again varies in the larger mass planting areas between buildings.

Eucalyptus microcorys (Tallowood)

Cupaniopsis anacardioides (Tuckeroo)

Brachychiton acerifolius (Flame Tree) Backhousia myrtifolia (Lemon Myrtle)

Three different types of mass planting have been defined in the masterplan to denote different uses; Open Space, Streetscape and Private Space.

Trees, accent planting and groundcovers each contribute to the amenity of each space, provide a variety of levels of

define the function of each area. Species have been selected that reflect the existing vegetation of the site, the local climate as well as provide some moments of seasonal interest.

Open Space Low native ground covers are used on

the perimeter of the open space areas. These plants will stabilise the batter and have low maintenance requirements.

Low native grasses are used within the

maintenance edge whilst maintaining

Mixture of native and exotic species of a residential scale. Screening planting provided on each property boundary to give privacy between buildings and

Species suitable for screening planted

on unit boundaries to provide pricavy. Syrygium 'cascade' (Lillypilly)

Syzygium 'resilience' (Resilience

Loropetalum chinensis (China doll)

streetscape to provide a low

from the adjacent land-uses.

good sightlines.

Private Space

Screenplanting

LETTERBOX

SEATING

PAVED PATIO (Refer to Architect)

EXISTING TREE TO BE RETAINED

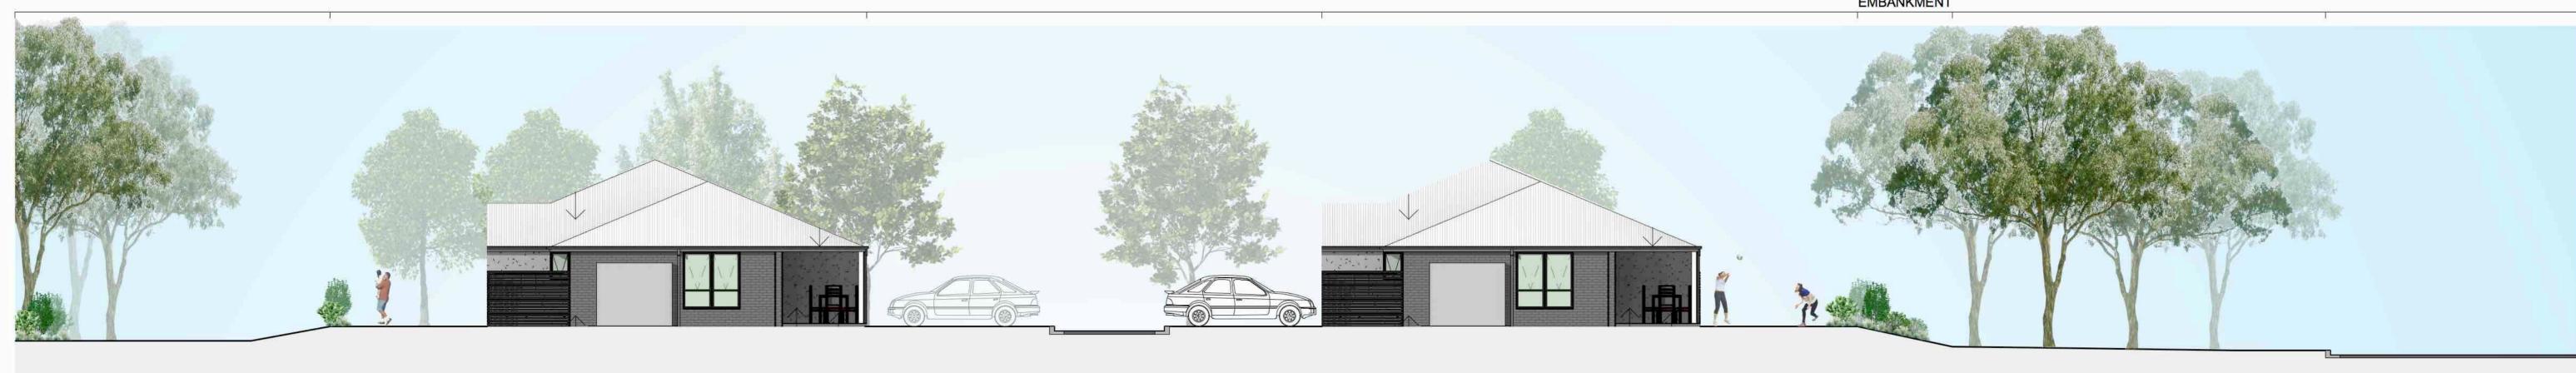
EXISTING TREE TO BE REMOVED

SCALE: 1:200 ORIGINAL DRAWING AT A1. Drawn By: BN

Checked By: DM

1380 Drawing No. Rev LP-006 B

Project No.



SECTION A - OPEN PARK 1:100 at A1

ROAD

BUFFER BETWEEN PRIVATE COURTYARDS

SHELTER COMMUNAL OPEN SPACE

BUFFER BETWEEN

PRIVATE COURTYARD

PRIVATE COURTYARDS

SECTION B - CENTRAL OPEN SPACE 1:100 at A1

UNIT WITH PRIVATE COURTYARD

FOOTPATH SHELTER COMMUNAL OPEN SPACE

UNIT WITH PRIVATE COURTYARD



SECTION C - BIN/MAIL ENCLOSURE & POCKET PARK 1:100 at A1

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DRAFT STAGE 2: SHORTLAND WATERS 90 VALE STREET SHORTLAND, NSW 2307,

SECTIONS Project No. SCALE: 1:100 ORIGINAL DRAWING AT A1.

RETIREMENT VILLAGE LOT 1 DP1215916 AVEO GROUP



Syzigium 'cascade' Lillypilly



Blechnum cartilagineum Gristle Fern



PLANT SCHEDULE

GROUND COVERS/LOW SHRUBS

SCIENTIFIC NAME

Pyrus calleryana 'Chanticleer' Brachychiton acerifolius

Cupaniopsis anacardioides

Hymenosporum flavum

Waterhousia floribunda

Eucalyptus microcorys

Tristaniopsis laurina

Backhousia myrtifolia

Lophostemon confertus

Myoporum parvifolium

Goodenia ovata

Hibbertia scandens

Doryanthes excelsa

Anigozanthos flavidus

Hymenocallis littoralis

Westringia fruticosa

Lomandra longifolia

Poa labillardieri 'Eskdale'

Carex appressa

Dianella caerulea

Pennisetum 'Nafray'

Syzygium resilience

Syzigium 'cascade'

Loropetalum chinensis

Dichondra repens

Viola hederacea

Cordyline spp.

Doodia aspera

CODE

TREES

PYR cal

BRA ace

CUP ana

HYM fla

WAT flo

EUC mic

BAC myr

LOP con

MYO par

GOO ova

HIB sca

DIC rep

VIO hed

DOR exc

ANI fla

HYM lit

WES fru

DOO asp

GRASSES LOM tan

CAR app

POA lab

DIA cae

PEN naf

SYZ res

LOR chi

SYZ cas

SCREENING SHRUBS

COR spp.

TRI lau

Doodia aspera Prickly Rasp Fern



Cordyline spp.

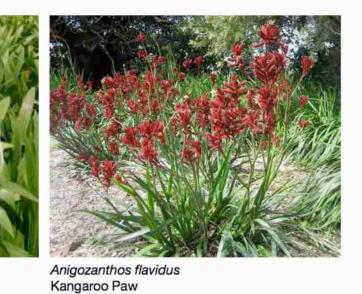


Westringia fruticosa

Coastal Rosemary



Spider Lilly







Hibbertia scandens Snake Vine

Doryanthes excelsa

Gymea Lilly

Myoporum parvifolium Creeping Boobialla

Poa labillardieri

'Eskdale'

Dichondria repens Kidney Weed







Dianella caerulea

Blue Flax Lilly



Mat Rush

Lomandra longifolia







Tallowwood

Brachychiton acerifolius Flame Tree

Pyrus calleryana 'chanticleer' Ornamental Pear

Hymenosporum flavum Native Frangipani

Fountain grass







Cupanaiopsis anacardioides Lophostemon confertus BrushBox Tuckeroo

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Watergum

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Architect: PALADIN PROJECTS	

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	A	3/2/17	LANDSCAPE DA FOR SUBMISSION	BN
ĺ	В	16/2/17	LANDSCAPE DA FOR RESUBMISSION	BN
				10-22-5

POT SIZE

75L 75L 75L 75L 75L 75L 75L 25L

75L

100mm

100mm

100mm

100mm

100mm 300mm

150mm

150mm

150mm 200mm

200mm

100mm

100mm

100mm

100mm

100mm

200mm

200mm

200mm

COMMON NAME

Ornamental Pear

Native Frangipani

Weeping Lillypilly

Creeping Boobialla Hop Goodenia

Snake Vine

Kidney Weed

Gymea Lilly

Kangaroo Paw Spider Lilly

Coastal Rosemary

Prickly Rasp Fern

Mat Rush

Tall Sedge

Tussock Grass

Blue Flax Lilly

Fountaingrass

China doll

Lillypilly

Resilience lillypilly

Ivy-Leaved Violet

Flame Tree

Tallowwood

Watergum Grey Myrtle

Brushbox

Tuckeroo





PERMEABLE PAVING

BROOM FINISH CONCRETE EXPOSED AGGREGATE CONCRETE



OPEN STYLE TIMBER SHELTER

SKILLION ROOF TIMBER SHELTER

PARK BENCH **CURVED CONVERSATION BENCH**





FEATURE LIGHT BOLLARDS

SANDSTONE RETAINING WALLS




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PLANTING & THEMING SCALE: 1:200 ORIGINAL DRAWING AT A1.

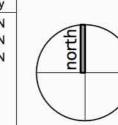1380 Drawing No. Rev Drawn By: BN LP-008 B Checked By: DM